


WINDOW SCHEDULE				
TAG	W X H	TYPE	HEADER	NOTES
(A1)	2-6 X 4-0	FIXED	6"-8" AFF	PROFILE TO MATCH CASEMENT
(A2)	2-6 X 4-0	CSMT	6"-8" AFF	DIRECTION SHOWN ON ELEV.
(B)	3-3 X 1-6	FIXED	6"-8" AFF	COORDINATE HT. W/ SHELF & ROD
(C)	3-0 X 2-0	AWN	7"-4" AFF	
(D1)	3-0 X 2-6	FIXED	FIELD VFY.	PROFILE TO MATCH AWNING
(D2)	3-0 X 2-6	AWN	FIELD VFY.	SEE NOTE 2 FOR D1 & D2
(E1)	3-0 X 5-0	S.H.	6"-8" AFF	1/2 VENT
(E2)	3-0 X 5-0	S.H.	6"-8" AFF	1/2 VENT - EGRESS UNIT
(F1)	3-0 X 3-0	FIXED	VARIABLES	SEE NOTE 3 - TEMP. AT STAIRS
(F2)	3-0 X 3-0	CSMT	4'-0" AFF	SEE NOTES 4&5 - TEMP. - EGRESS
(G)	3-0 X 3-9	S.H.	6"-8" AFF	SEE NOTE 6 - 1/2 VENT
(H)	3-0 X 3-6	FIXED	6"-8" AFF	TEMPERED


NOTES:  
 1. TEMPER UNITS AS REQUIRED BY CODE.  
 2. MAXIMIZE WINDOW DIMENSION WITHIN AVAILABLE SPACE - FIELD VERIFY (ALLOW SPACE FOR PROPER ROOF FLASHING)  
 3. COORDINATE HEADER HEIGHTS WITH ELEVATIONS & STAIRS - FIELD VERIFY  
 4. MAXIMIZE HDR. HT. BASED ON ROOF CLEARANCE TO ALLOW FULL OUTSWING  
 5. 6"-8" HEADER HEIGHT NON-TEMPERED, NON-EGRESS AT SIMILAR CONDITION  
 6. VERIFY WINDOW HEIGHT TO ALLOW FOR SILL AT COUNTERTOP HEIGHT

A


TYPICAL WINDOW DETAILS  
NOT TO SCALE

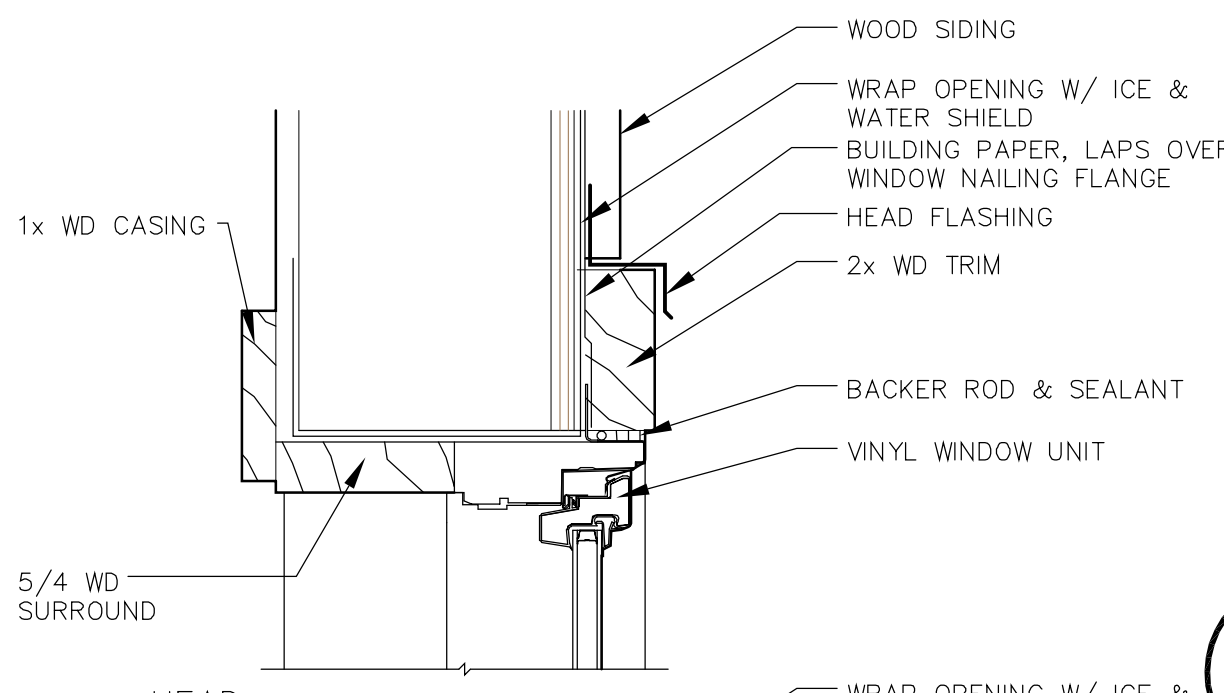



B

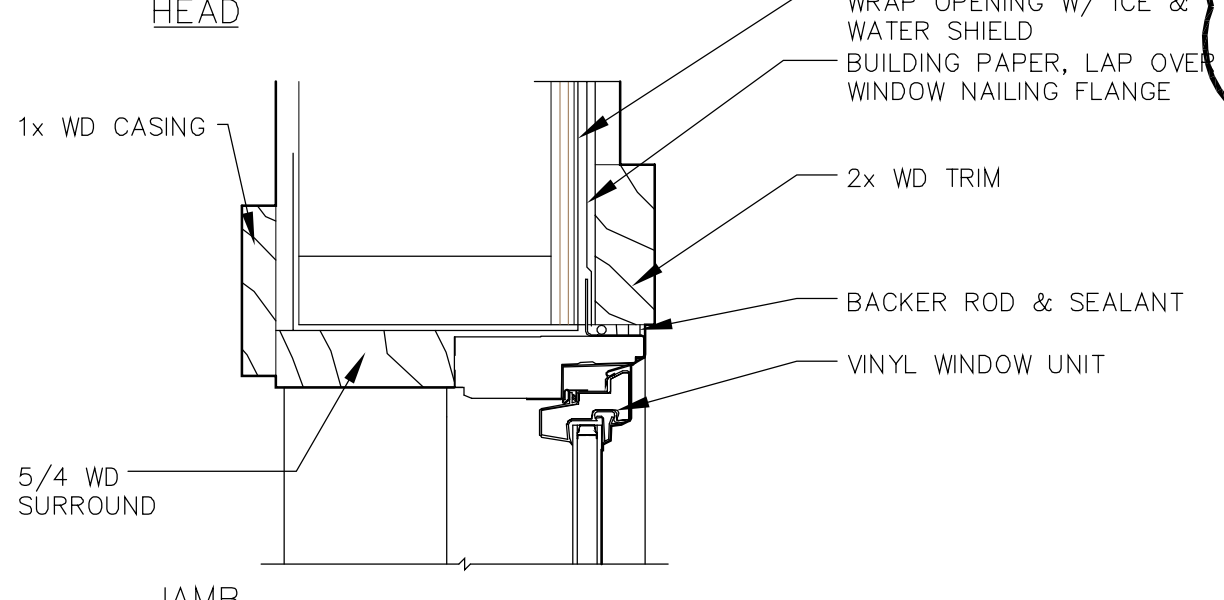


C

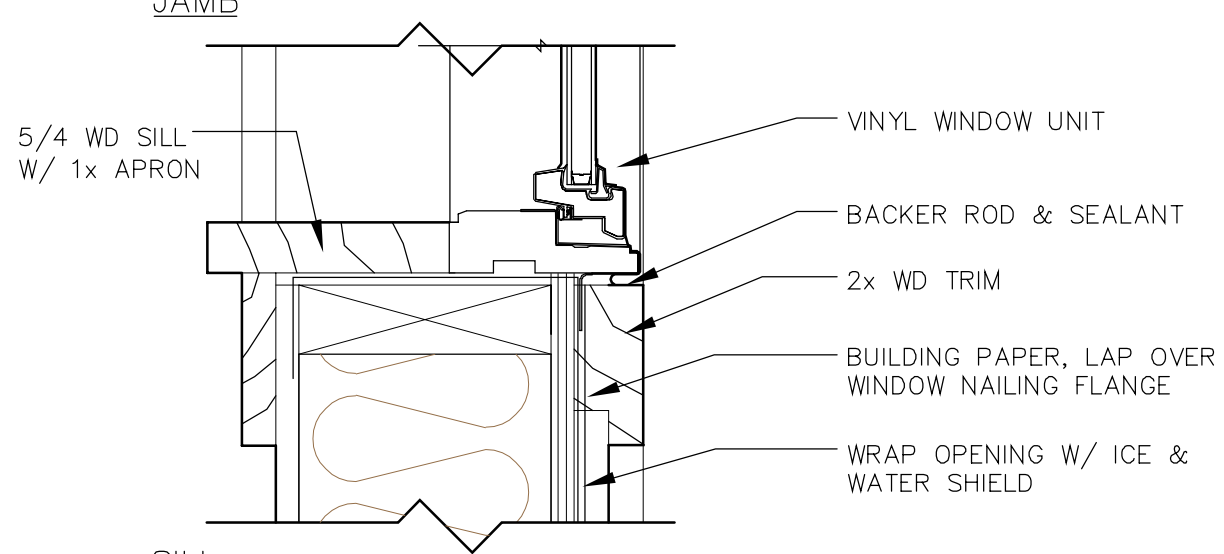


D

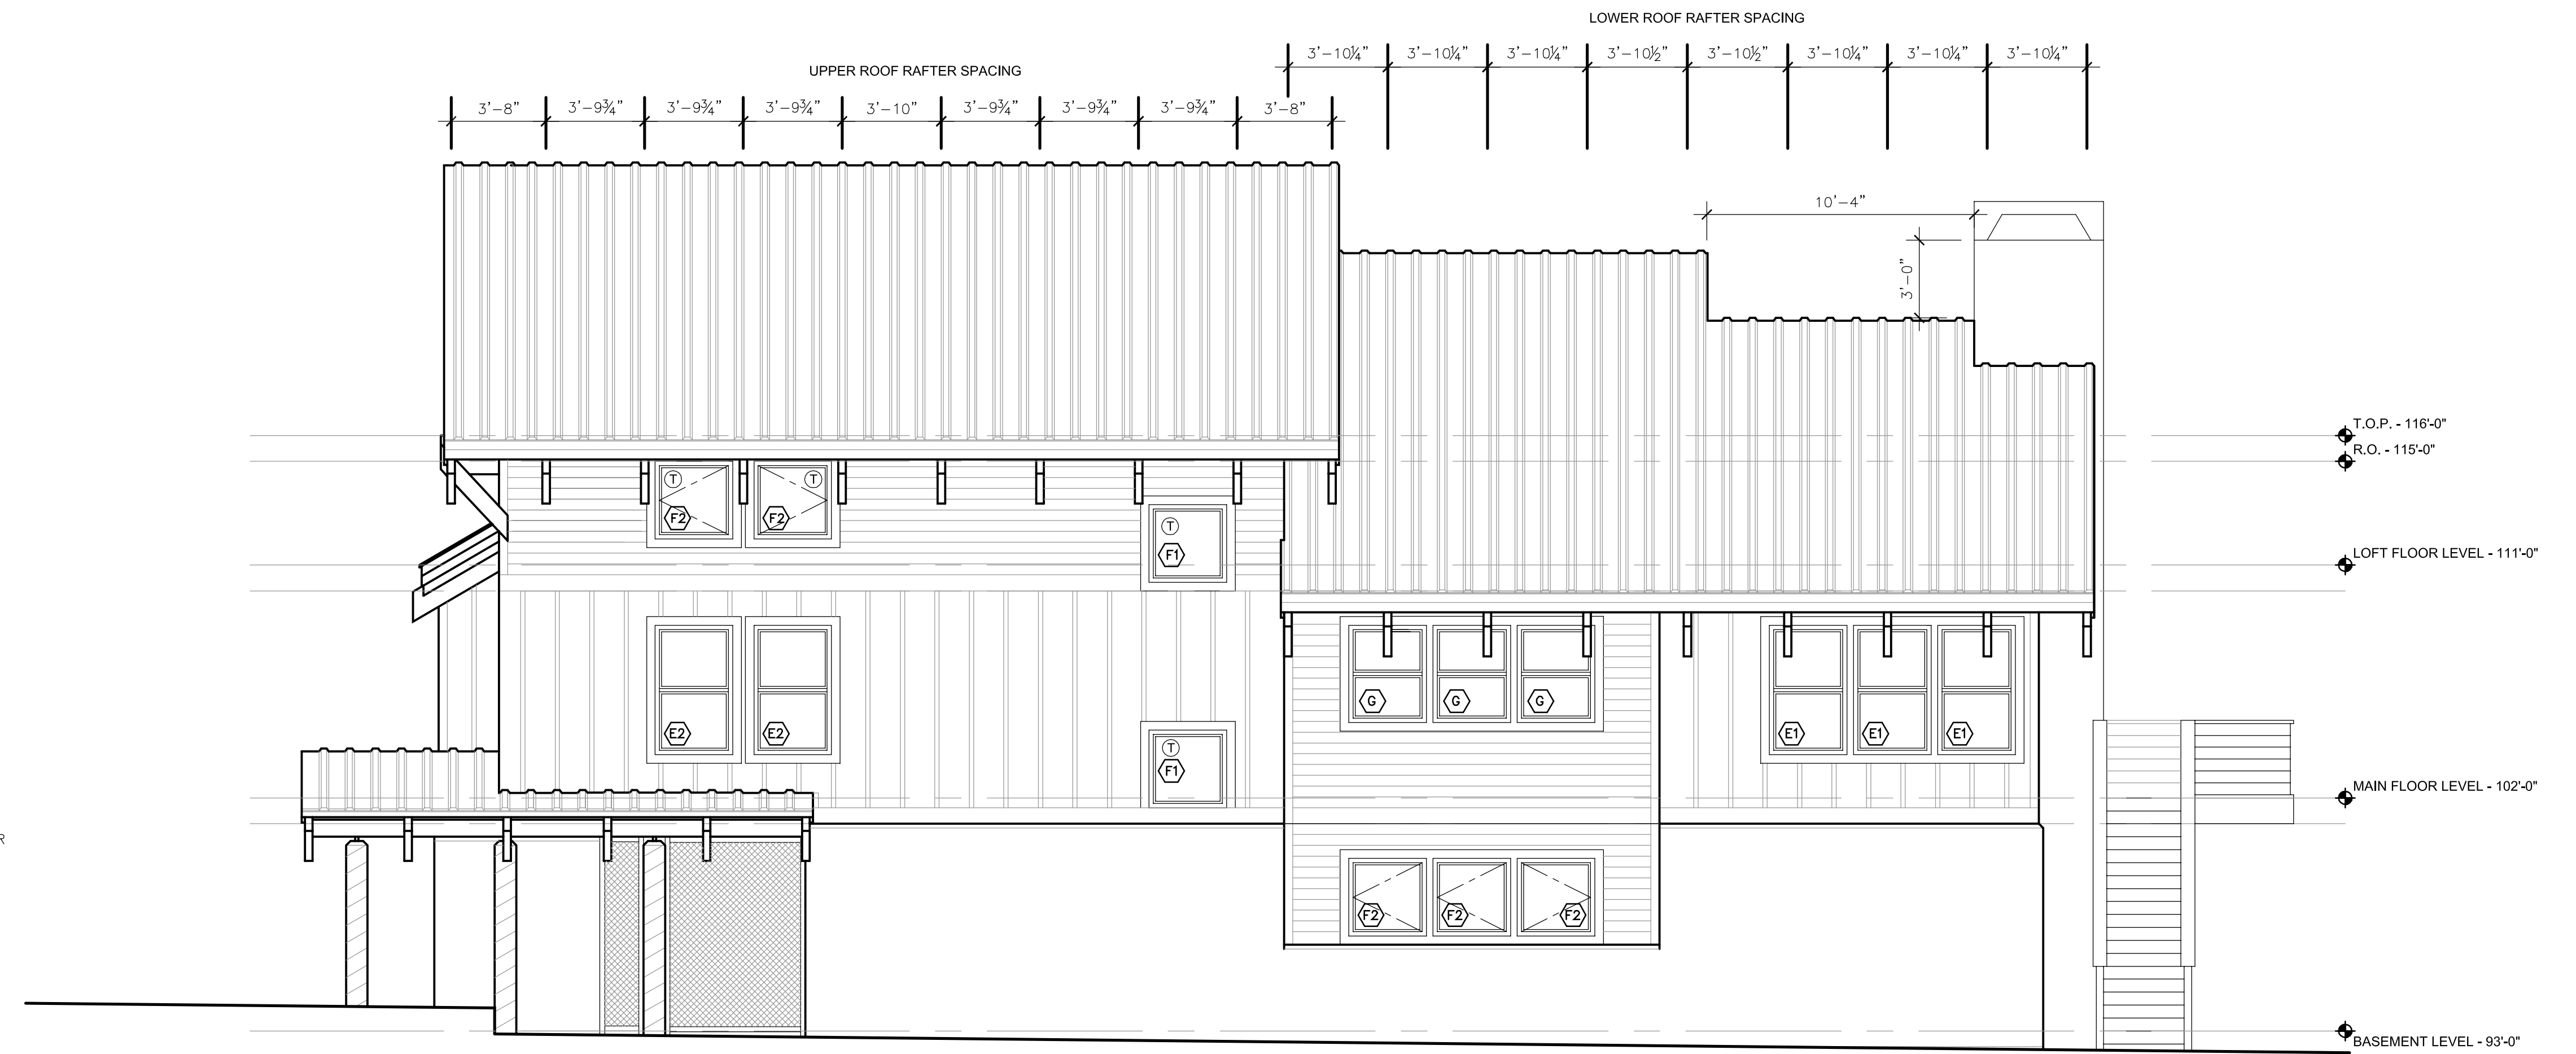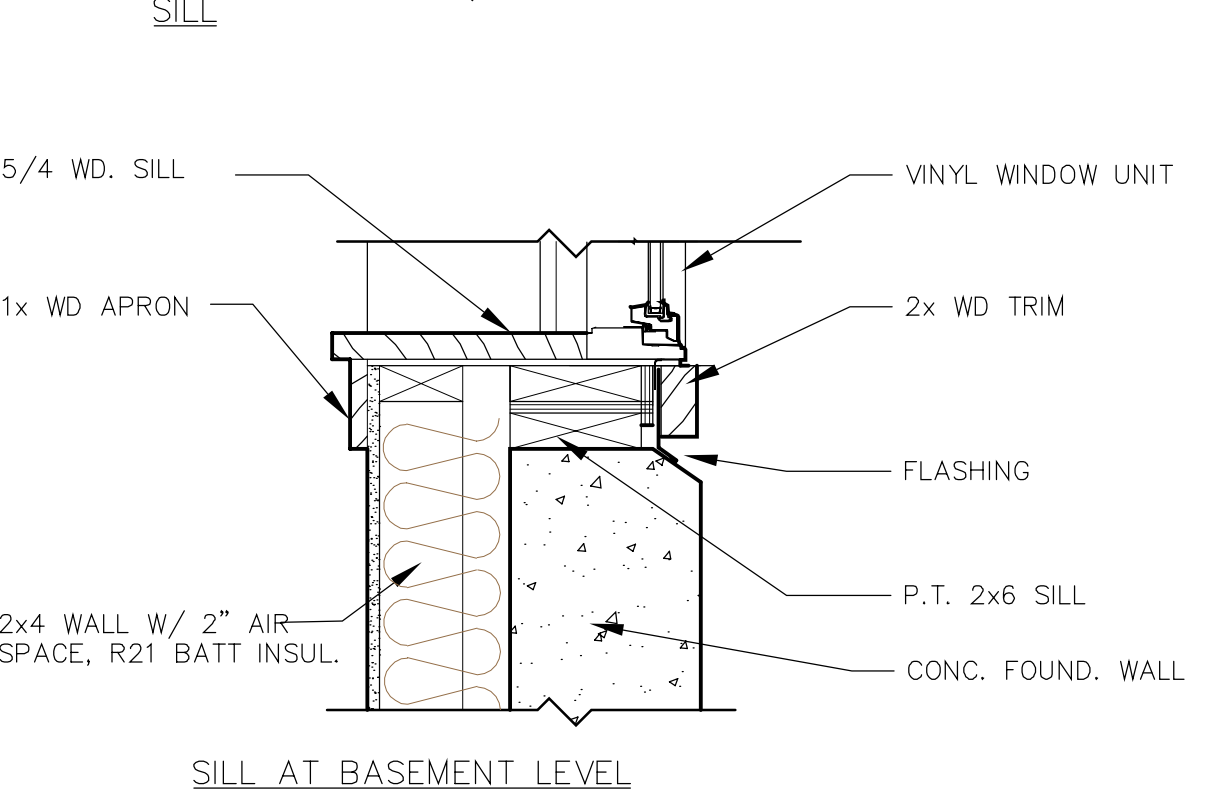

1 WEST ELEVATION  
1/4" = 1'-0"

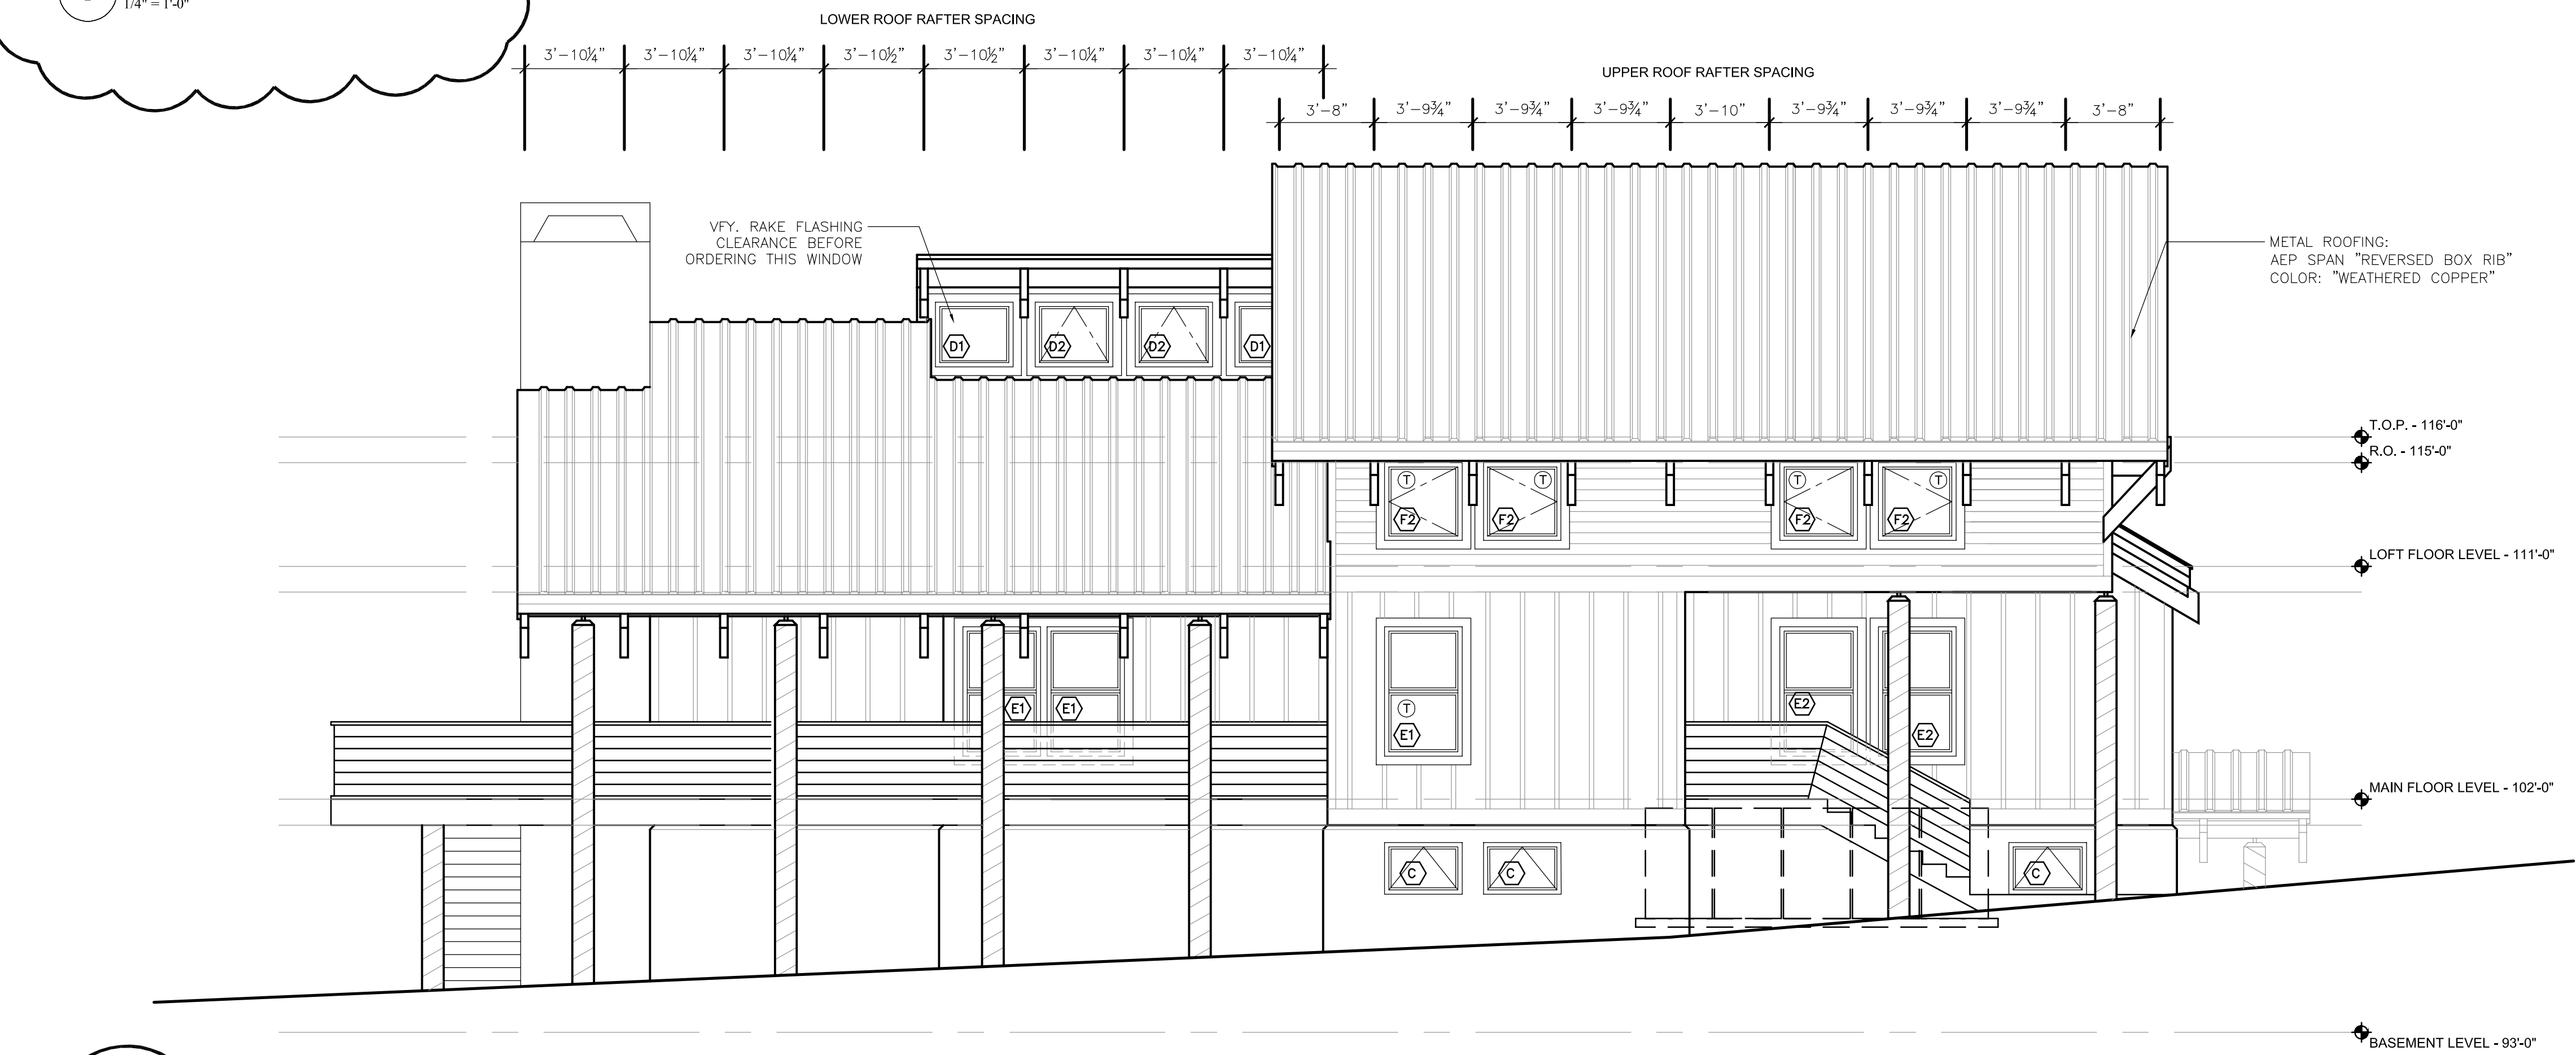

2 EAST ELEVATION  
1/4" = 1'-0"

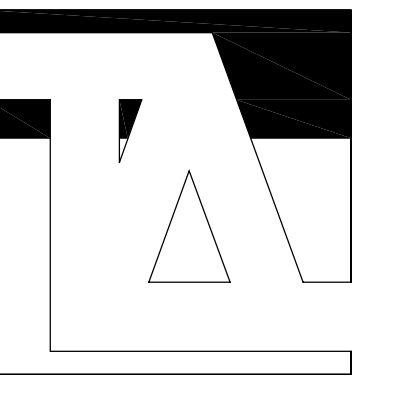

SANDLER / SROFE MOUNTAIN DWELLING  
 GOVERNMENT CAMP, OREGON  
 EXTERIOR ELEVATIONS

REVISED: 02.28.05  
 REVISED: 04.10.04  
 DATE: 02.27.04  
 CHECK:  
 DRAWN BY: TLA  
 PROJECT #: mndwlg

SHEET:  
**A 4**